
CUSTOM HOME ADDITION


CORDILLERA VALLEY CLUB FIL 7 LOT 4 1846 BEARD CREEK TRAIL EDWARD, CO 81632

DRB Submittal - 01/06/2025

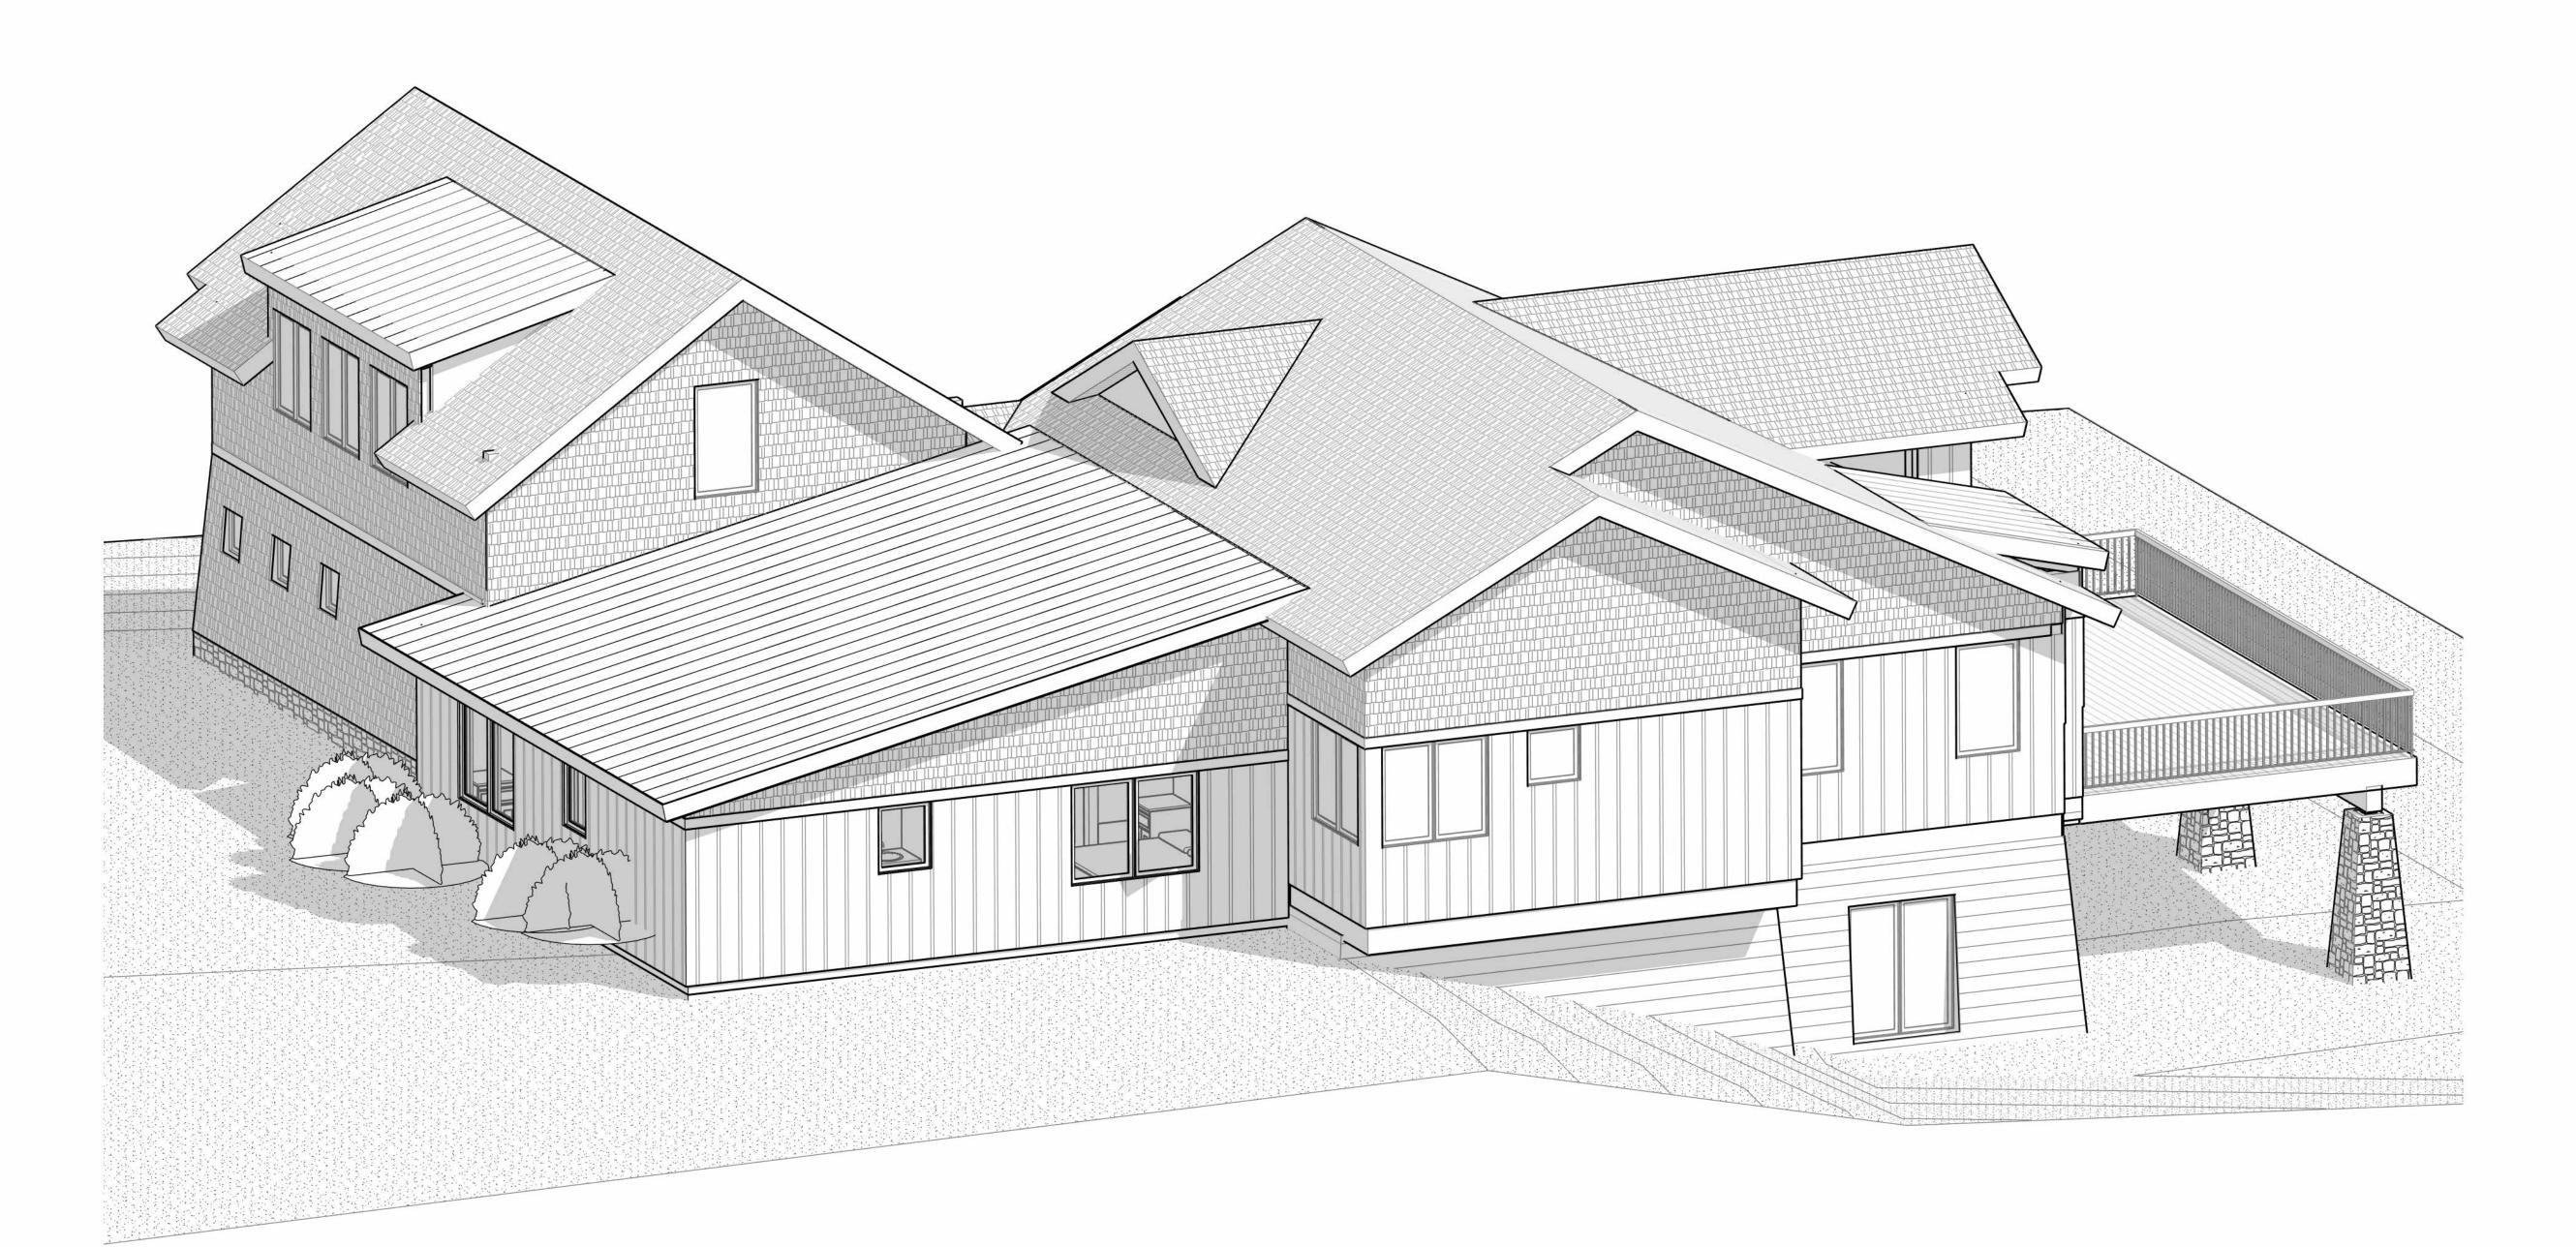

Sheet List						
Sheet Name						
DEMO MAIN LEVEL PLAN						
COVER						
GENERAL NOTES & WALL TYPES						
PHOTOS						
SURVEY						
SITE PLAN						
LANDSCAPE PLAN						
CONSTRUCTION MANAGEMENT PLAN						
AREA PLANS						
LOWER LEVEL PLANS						
MAIN LEVEL PLANS						
DEMO ROOF PLAN						
REMODEL ROOF PLAN						
SOUTH EXT. ELEVATIONS						
EAST EXT. ELEVATIONS						
BUILDING SECTIONS						
CONSTRUCTION DETAILS						

GENERAL SYMBOLS

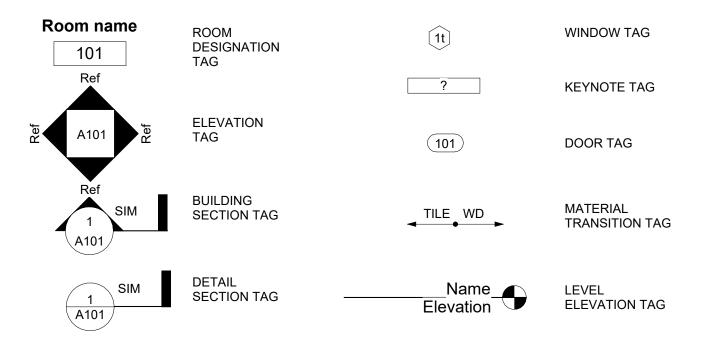

GENERAL SYMBOLS 1/4" = 1'-0"

GENERAL NOTES:

Do not scale drawings.

- Dimensiosn to face of stud and/or concrete foundation unless noted otherwise.
- Thorough effort is made to provide a complete and clear set of construction documents. In the case of discrepancies, ommisions, or missing information required to complete construction Contractor to contact Architect and/or Engineer for clarification.
- Contractor to provide shop drawings for review by Engineer/Architect/Interior Designer for the following but not limited to: steel beams, steel columns, steel connections, casework, trusses.
- Refer to manufactures shop drawings for exact window and door rough openings.

WALL STYTEMS:

- Typical foundation wall to W-1, u.n.o.
- Typical exterior wall to be Type W-2, u.n.o. Typical furring wall to be W-3, u.n.o.
- Typical interior walls to be either W-4 or W-5, u.n.o.
- Typical double wall to be W-6, u.n.o.

FLOOR SYSTEMS:

1. Lower Level: Concrete slab on Grade on 6 mil. or 3 mil. cross-laminated vapor barrier - See Structural for slab requirements

FRAMING NOTES:

- Provide all necessary blocking in stud cavities in walls and ceiling for the following locations, but not limited to, toilet and bath accessories, wall and ceiling mounted electrical fixtures, window treatments, closet rod and shelf, cabinetry, and countertops.
- 2. All exterior sill plates on concrete to be pressure treated to be seperated from concrete with DOW -
- Any gaps between sill plate and concrete greater than 1/4" to be shimmed w/ metal shims and to be foamed with expanding urethane.
- Framing gaps not able to be insulated to be foamed with expanding urethane spray foam.
- Window and Door Jamb gaps to be foamed with expanding urethane spray foam. All steel located below and exposed to grade to be coated with bituminous damproofing.

DRYWALL AND PAINT:

- All drywall to be shimmed and screwed.
- Drywall to have a Level 4 finish min. No joints, tape marks, screw heads, or patches should be visible. Provide sample for approval.
- Drywall texture to match exist. Provide sample for approval.
- Drywall corners and transitions to match exist.
- Paint to be of high quality acrylic, 2 coats over 1 coat latex primer. Color to be determined by Owner.

MECHANICAL & PLUMBING NOTES:

- All Mechanical Systems to be design-build.
- Coordinate all mechanical to fit within ceiling, floor, and wall cavity spaces.
- Primary heating to be forced air heat from existing system mechanical contractor to verify existing system is sufficient to handle new area.
- Plumbing fixtures and fittings to be chosen by Owner. All finishes are to be the same as main fitting or adjacent fittings. RE: Interior drawings. Hot water should be on an insulated hot water re-circulation line and pump.
- Drain lines running in walls adjacent to living spaces to be in cast iron, transitioning to PVC below
- Supply lines should be properly sized and run independently as required to prevent temperature change at the shower when other plumbing fixtures are being used.
- Supply lines whether in-floor or wall, drain traps, or outlets should not be located as to interfere with roll out shelves in base cabinets.
- Mechanical sub-contractor to provide the following information when applying for permit:
 - System specs, including equipment types, sizes, and efficiencies.
 - Equipment and system controls specification/cut sheets.

EDITIONS OF THE:

CODE INFORMATION: ALL WORK WILL BE COMPLETED IN ACCORDANCE WITH THE LATEST ADOPTED

2018 INTERNATIONAL BUILDING CODE 2018 INTERNATIONAL RESIDENTIAL CODE 2018 INTERNATIONAL FIRE CODE 2018 INTERNATIONAL PLUMBING CODE 2018 INTERNATIONAL MECHANICAL CODE

2018 INTERNATIONAL FUEL GAS CODE 2018 INTERNATIONAL ENERGY CONSERVATION CODE

OCCUPANCY CLASS: GROUP R3/310.5

TYPE OF CONSTRUCTION: TYPE VB/602.5 **SEPARATIONS PER R302.5**

CLIMATE ZONE: 6B PER N1101.7

ceilings @ trusses.

OF STORIES - 2

THERMAL ENVELOPE: Prescriptive Method - Equals exterior walls & roof or

PROJECT INFO: LOCATION:

INTERIOR

INTERIOR

cordillera valley club Fil 7 Lot 5 1844 Ceard Creek Trail Edwards, CO 81632

DATUM REFERENCE:

T.O. Plywood 100'-0" = 7247.0' USGS LOT ACREAGE - 0.275 Acres

PROJECT DIRECTORY: OWNER: Marty & Hilli Sheck 1446 Presidential Way

Miami, FL 33179

ARCHITECT: NDG Architecture PO Box 634 Edwards, Co 81632 (970) 471-0698 Bill Nutkins, AIA, NCARB bnutkins@ndg-inc.com

STRUCTURAL ENGINEER: **IMEG** 70 Benchmark Road


Avon, CO 81620 (970) 949-7768 Leslie J. Wyse Leslie.J.Wyse@imegcorp.com

CONTRACTOR: **Rocky Mountain Creations** PO Box 484 Wolcott, CO 81655 Jimmy DeLong jardelong@aol.com

EXTERIOR INTERIOR EXTERIOR 1/2" AIR SPACE 6 MIL VAPOR BARRIER INSIDE EXTERIOR WALL TYPE 4 SIM. FACE OF STUDS, TAPE AND SEAL TOP, BOTTOM AND SEAMS 3 1/2" CLOSED CELL SPRAY FOAM INSULATION (R-21 MIN.) 5/8" GYP. BOARD INTERIOR FURRING WALL TYPE 3 SIM, EXCEPT 2X4 FLAT, FILL W/ FOUNDATION WALL BATT INSULATION RE: STRUCT FOUNDATION WALL FLOOR STRUCTURE RE: STRUCT

CONC LEDGE FURRING WALL W-3: TYPICAL FURRING WALL INTERIOR

THE INTERIOR

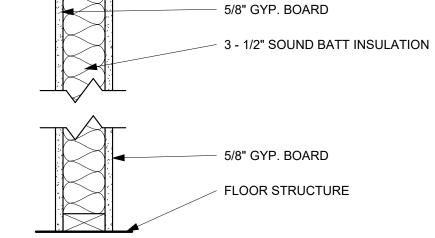

W-4: TYPICAL 2X4 INTERIOR WALL

INTERIOR 5/8" GYP. BOARD 5 - 1/2" SOUND BATT INSULATION 5/8" GYP. BOARD FLOOR STRUCTURE

W-5: TYPICAL 2X6 INTERIOR WALL - SUB DURAROCK IN WET AREAS

INTERIOR EXTERIOR INTERIOR **EXTERIOR** 1 1/2" RIGID INSULATION TO 48" BELOW GRADE (CONTRACTOR OPTION FOR 2" SHOCK WAVE) AMERICAN HYDRODUCT OR EQUAL 5/8" GYP. BOARD ON BITUTHENE 3000 WP FROM BOTTOM OF FOOTING TO 30" A.F.G. 6 MIL VAPOR BARRIER INSIDE (CONTRACTOR OPTION FOR 2" FACE OF STUDS, TAPE AND SHOCK WAVE) SEAL TOP, BOTTOM, AND CONC SLAB PER STRUCTURAL CONCRETE FOUNDATION WALL SEAMS AND FOOTING RE: STRUCTURAL TYVEC COMMERCIAL ON 1/2" SHEATHING ON 2X SLEEPERS ON 2X6 WOOD STUD WALL FRAMING WITH 3 1/2" CLOSED CELL SPRAY FOAM INSULATION (R-21 MIN.) EXTERIOR FINISH RE: ELEVATIONS, SHEATHING ON 2X6 STUD @ 16" O.C. **GRAVEL BACKFILL** STEEL ANGLE SUPPORT PER STRUCT FLOOR STRUCTURE 4" PERF PVC PERIMETER DRAIN 1 1/2" RIGID INSULTAION ON 6 MIL VB (CONTRACTOR OPRION FOR W-2: TYPICAL EXTERIOR WALL ECÒ FOIL COUBLE-BUBBLE) FOR 4'-0" FROM EDGE OF SLAB TO W-1: TYP FOUNDATION DETAIL

CL - CENTER LINE C-C - CENTER TO CENTER **CPT - CARPET** COL - COLUMN CONC - CONCRETE CONT - CONTINUOUS, CONTINUE **CJ - CONTROL JOINT** DTL - DETAIL **DIAG - DIAGONAL** DIA - DIAMETER **DW - DISHWASHER** DWG - DRAWING ELEC - ELECTRIC(AL) **ELEV - ELEVATION EXIST - EXISTING EXP - EXPANSION** EXT - EXTERIOR **NOT FOR** FD - FLOOR DRAIN FG - FIBERGLASS CONSTRUCTION FF - FINISHED FLOOR FLUOR - FLUORESCENT FP - FIREPLACE GA - GAUGE GYP - GYPSUM GWB - GYPSUM WALL BOARD HT - HEIGHT **HORZ - HORIZONTAL HW - HOT WATER** \bigcirc INSUL - INSULATION/INSULATE

ABBREVIATIONS

ALUM - ALUMINUM

BM - BEAM

BRG - BEARING

B.O. - BOTTOM OF

BLDG - BUILDING

BRD - BOARD

CLG - CEILING

EA - EACH

FT - FEET

HR - HOUR

JT - JOINT

MIN - MINIMUM

MTL - METAL

PL - PLATE

RM - ROOM

SHT - SHEET

STL - STEEL

STN - STONE

T.O. - TOP OF

TYP - TYPICAL

WD - WOOD

W/O - WITHOUT

W/ - WITH

SIM - SIMILAR

SCH - SCHEDULE

SF - SQUARE FOOT

THK - THICK(NESS)

THRU - THROUGH

TS - TUBE STEEL

VERT - VERTICAL

VEST - VESTIBULE

VB - VAPOR BARRIER

SPEC - SPECIFICATION

STRUCT - STRUCTURAL

T&G - TONGUE & GROOVE

UNO - UNLESS NOTED OTHERWISE

NO - NUMBER

OC - ON CENTER

MAX - MAXIMUM

MECH - MECHANICAL

MFR - MANUFACTURER

OD - OUTSIDE DIAMETER

OSF - OUTSIDE FACE OF

POLY - POLYETHYLENE

POLYST - POLYSTYRENE

PVC - POLYVINYL CHLORIDE

REINF - REINFORCE (D), (ING)

PSF - POUNDS PER SQUARE FOOT

PSI - POUNDS PER SQUARE INCH

PERF - PERFORATED

AB - ANCHOR BOLT


AFF - ABOVE FINISHED FLOOR


ARCH - ARCHITECT(URAL)

FIL RAII diti O E O MOR

> Job# 2024-020 Issue Date DRB Submittal - 01/06/2025

Drawing Name GENERAL NOTES & WALL TYPES

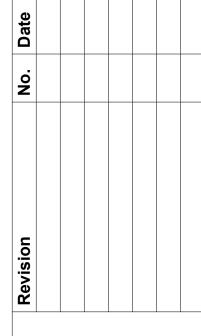

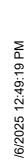











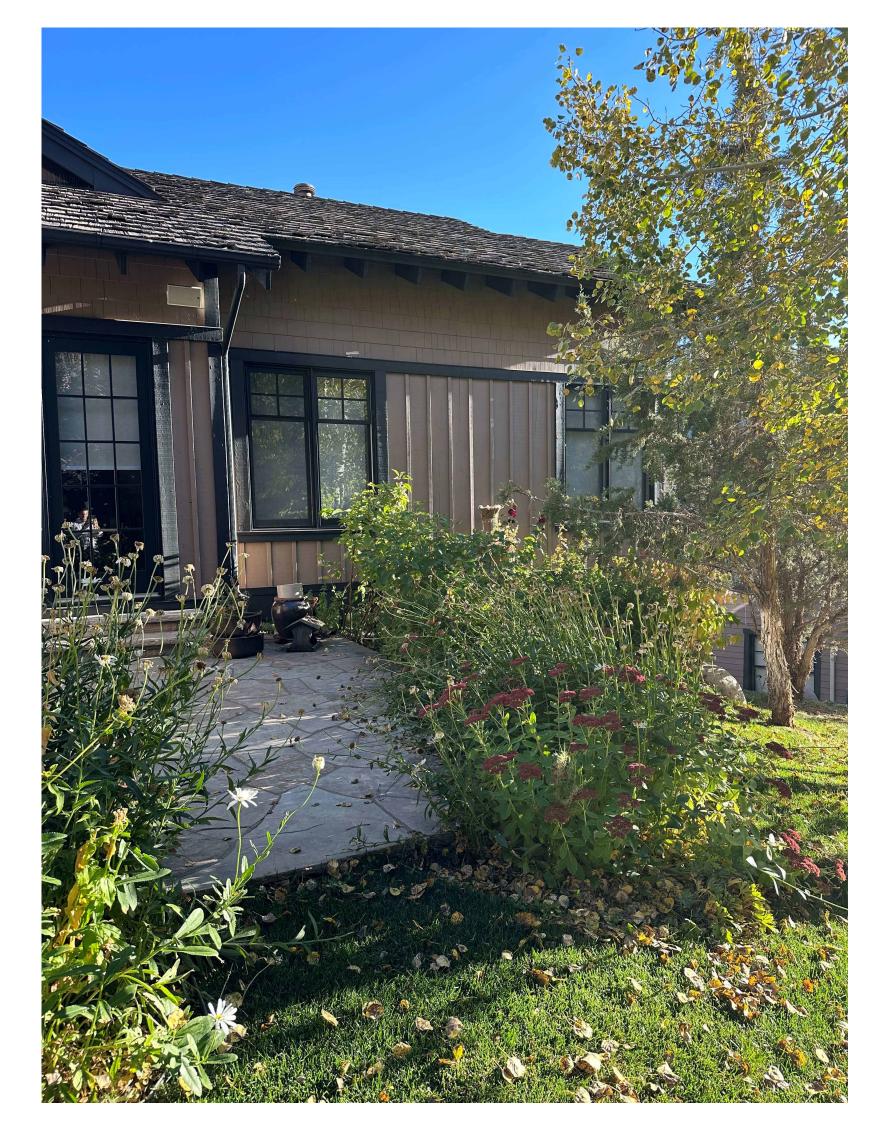


NOT FOR CONSTRUCTION

Job # 2024-020 **Issue Date** DRB Submittal - 01/06/2025

Drawing Name PHOTOS

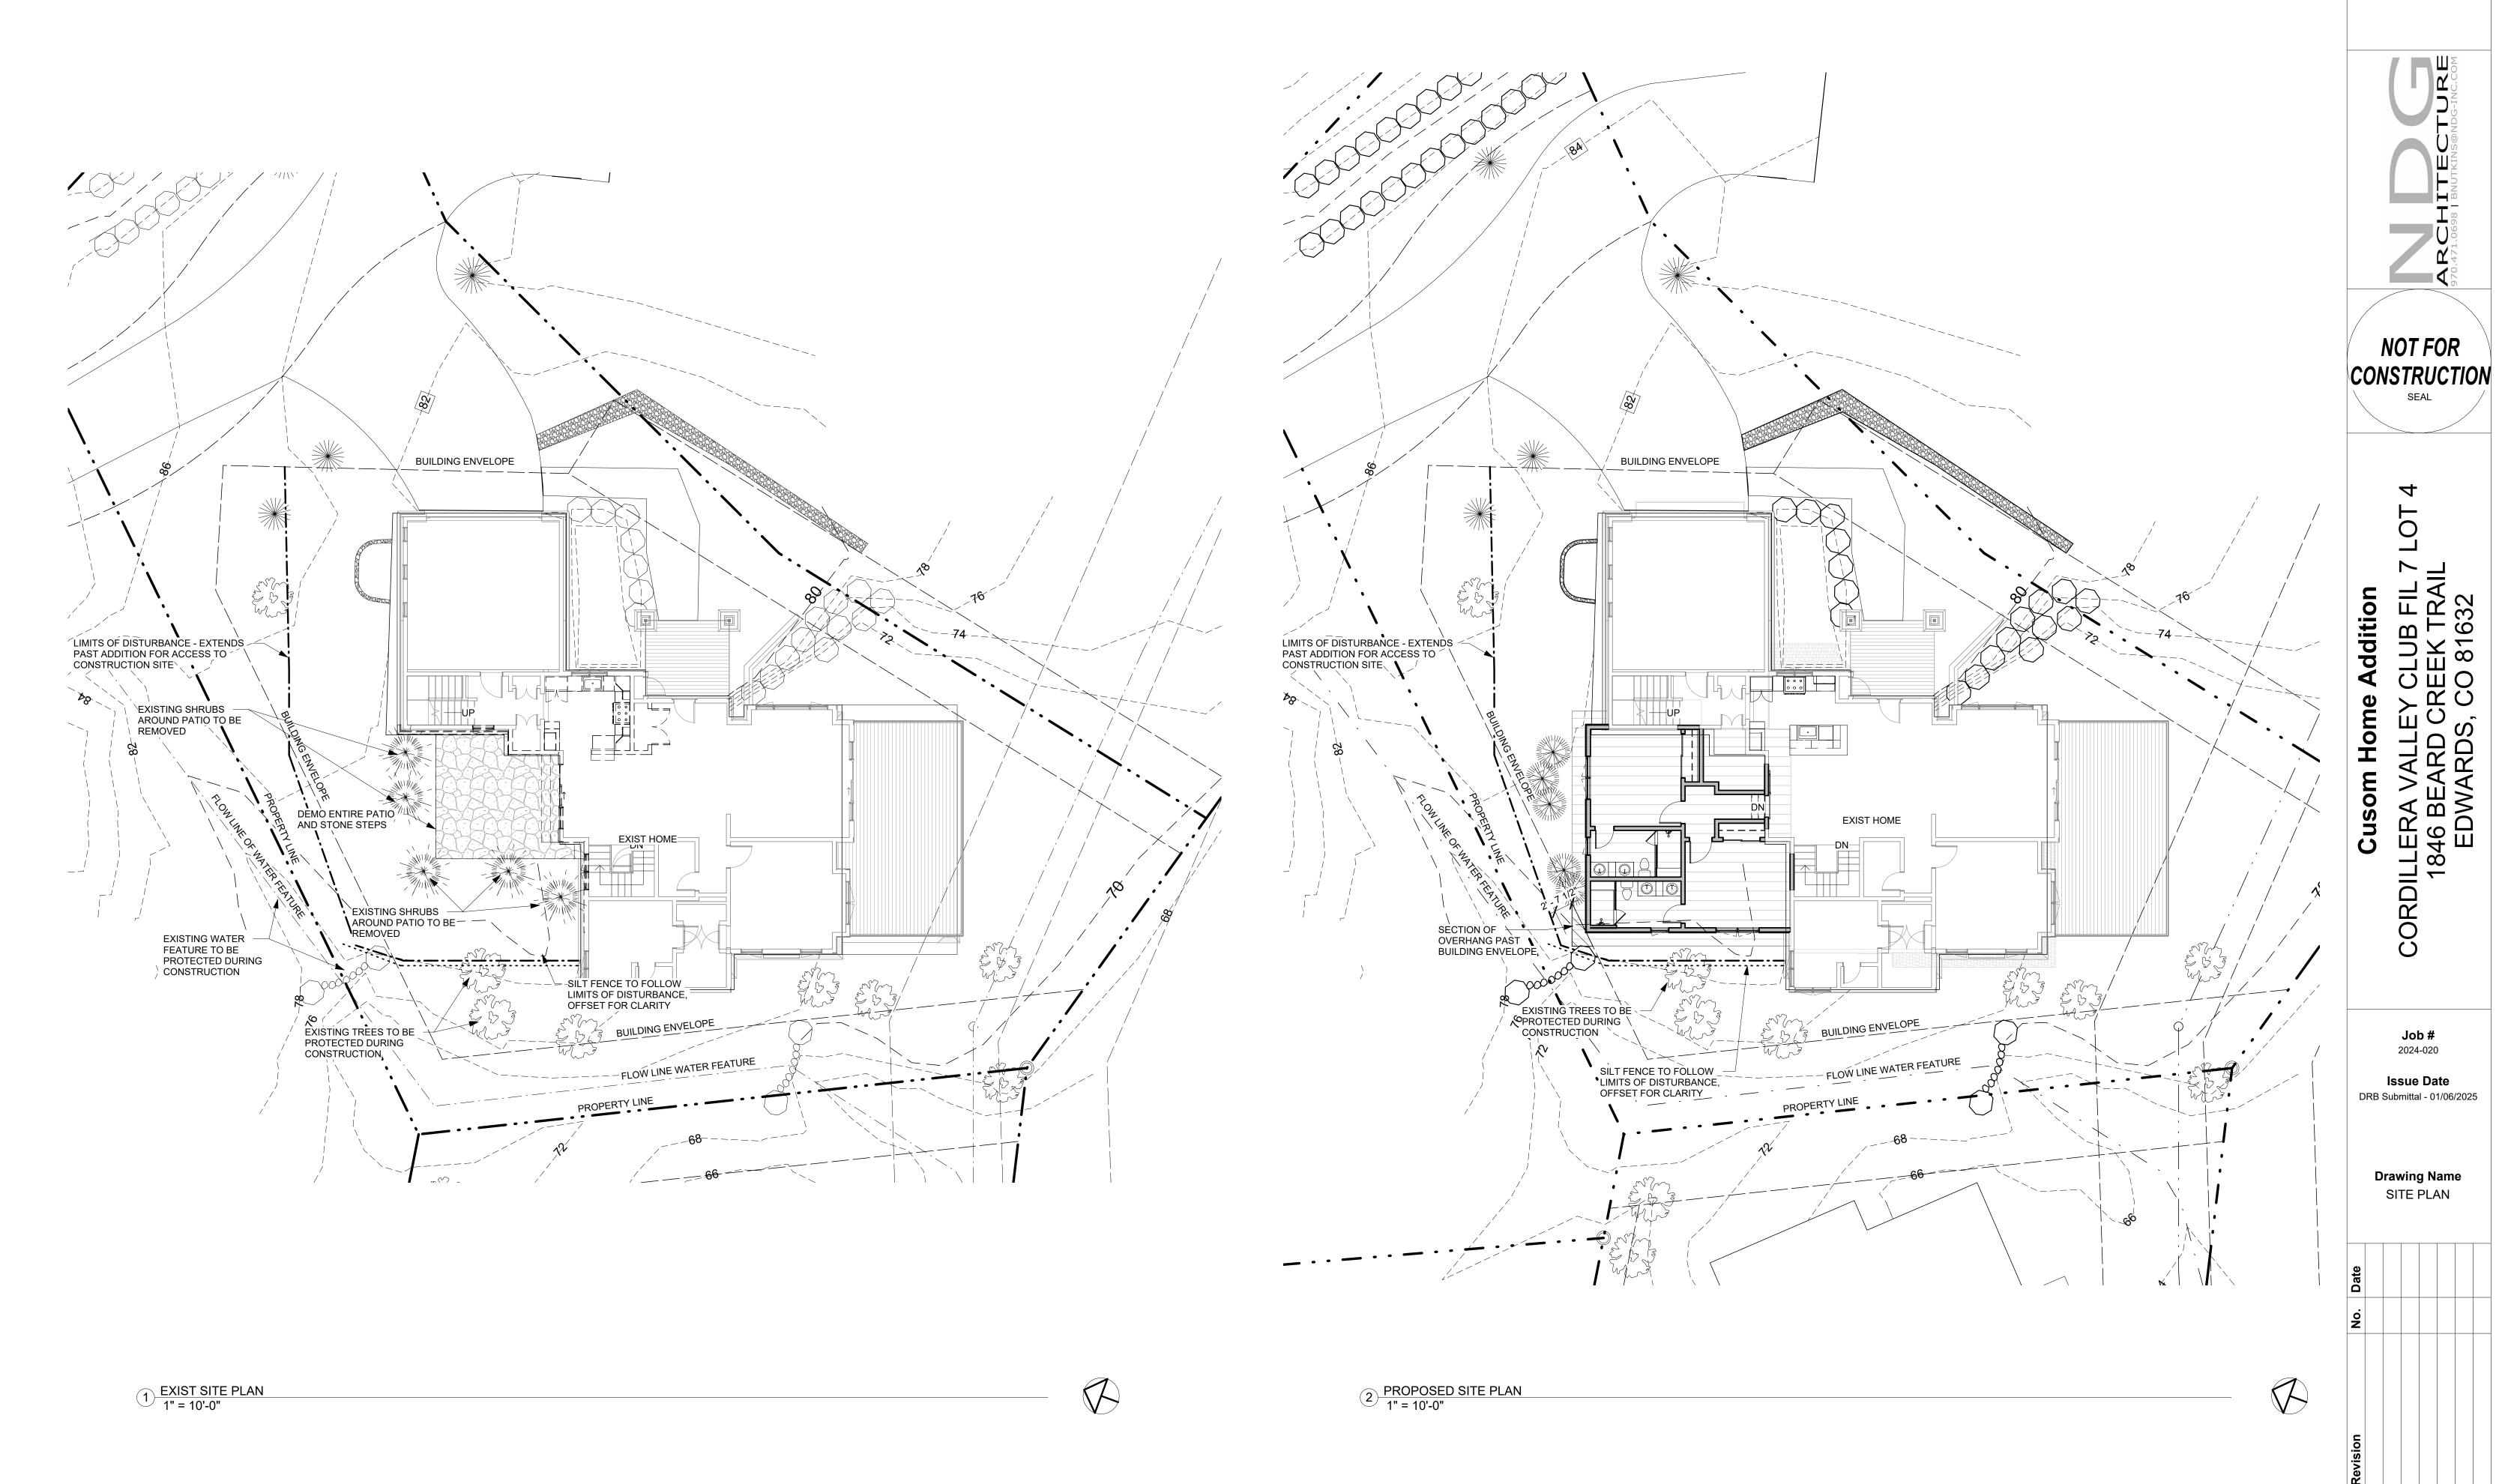

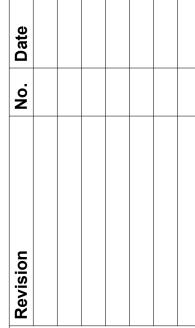

1 PROPOSED LANDSCAPE PLAN 1/8" = 1'-0"

PL - PURPLE LILAC 3 TOTAL






SS - SNOWMOUND SPIREA 2 TOTAL



Job# 2024-020

Issue Date DRB Submittal - 01/06/2025

Drawing Name LANDSCAPE PLAN

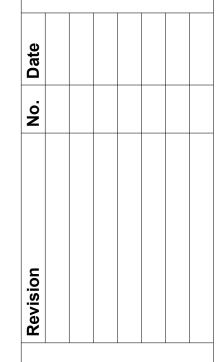


EXISTING AREA SCHEDULE Area Name EXIST LOWER LEVEL 1353 SF EXIST MAIN LEVEL Grand total: 2 3048 SF NEW AREA SCHEDULE

NEW LOWER LEVEL 385 SF

Grand total: 2

NEW MAIN LEVEL 712 SF

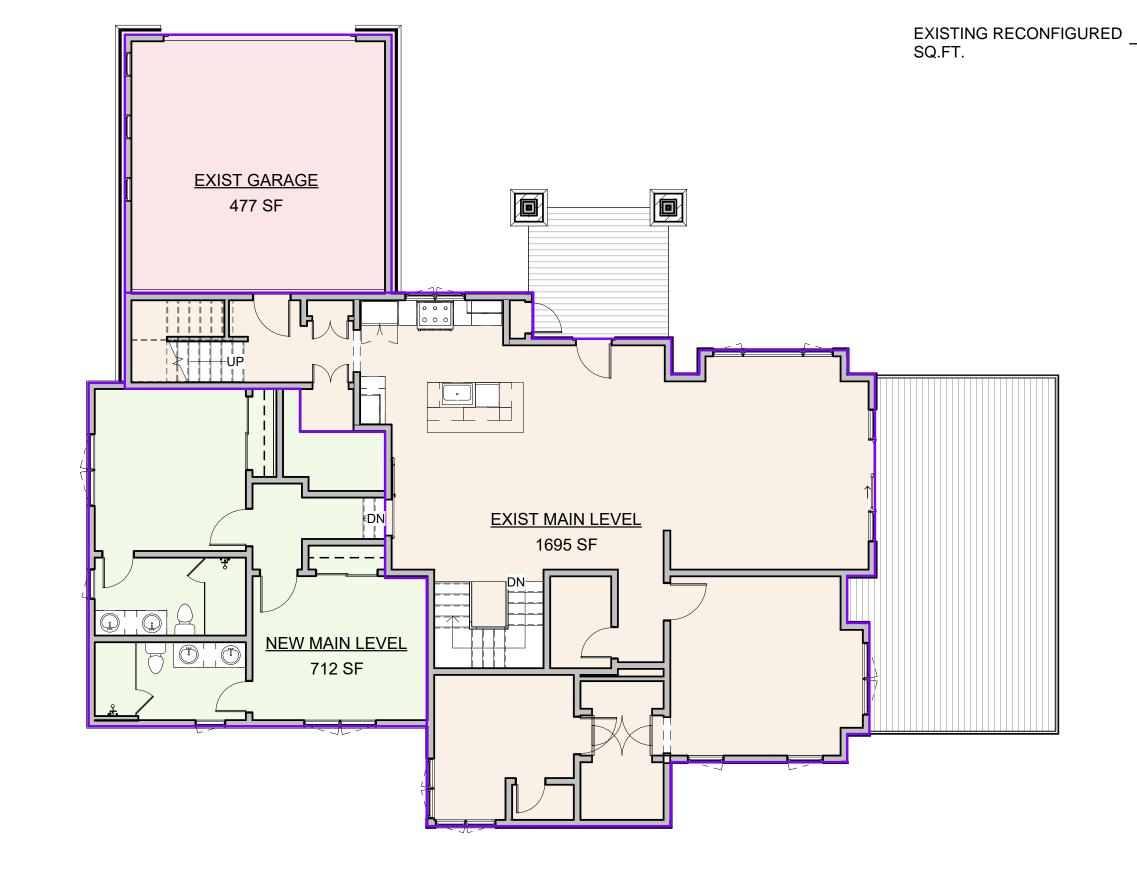

1 LOWER LEVEL - AREA PLAN 1/8" = 1'-0"

NEW LOWER LEVEL

385 SF EXIST NOT NEW EXIST LOWER LEVEL

1353 SF

2 MAIN LEVEL - AREA PLAN 1/8" = 1'-0"

CORDILLERA VA 1846 BEAF EDWAR


NOT FOR


CONSTRUCTION

Job# 2024-020

Issue Date DRB Submittal - 01/06/2025

Drawing Name AREA PLANS

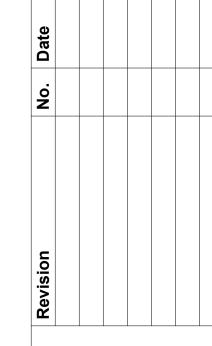

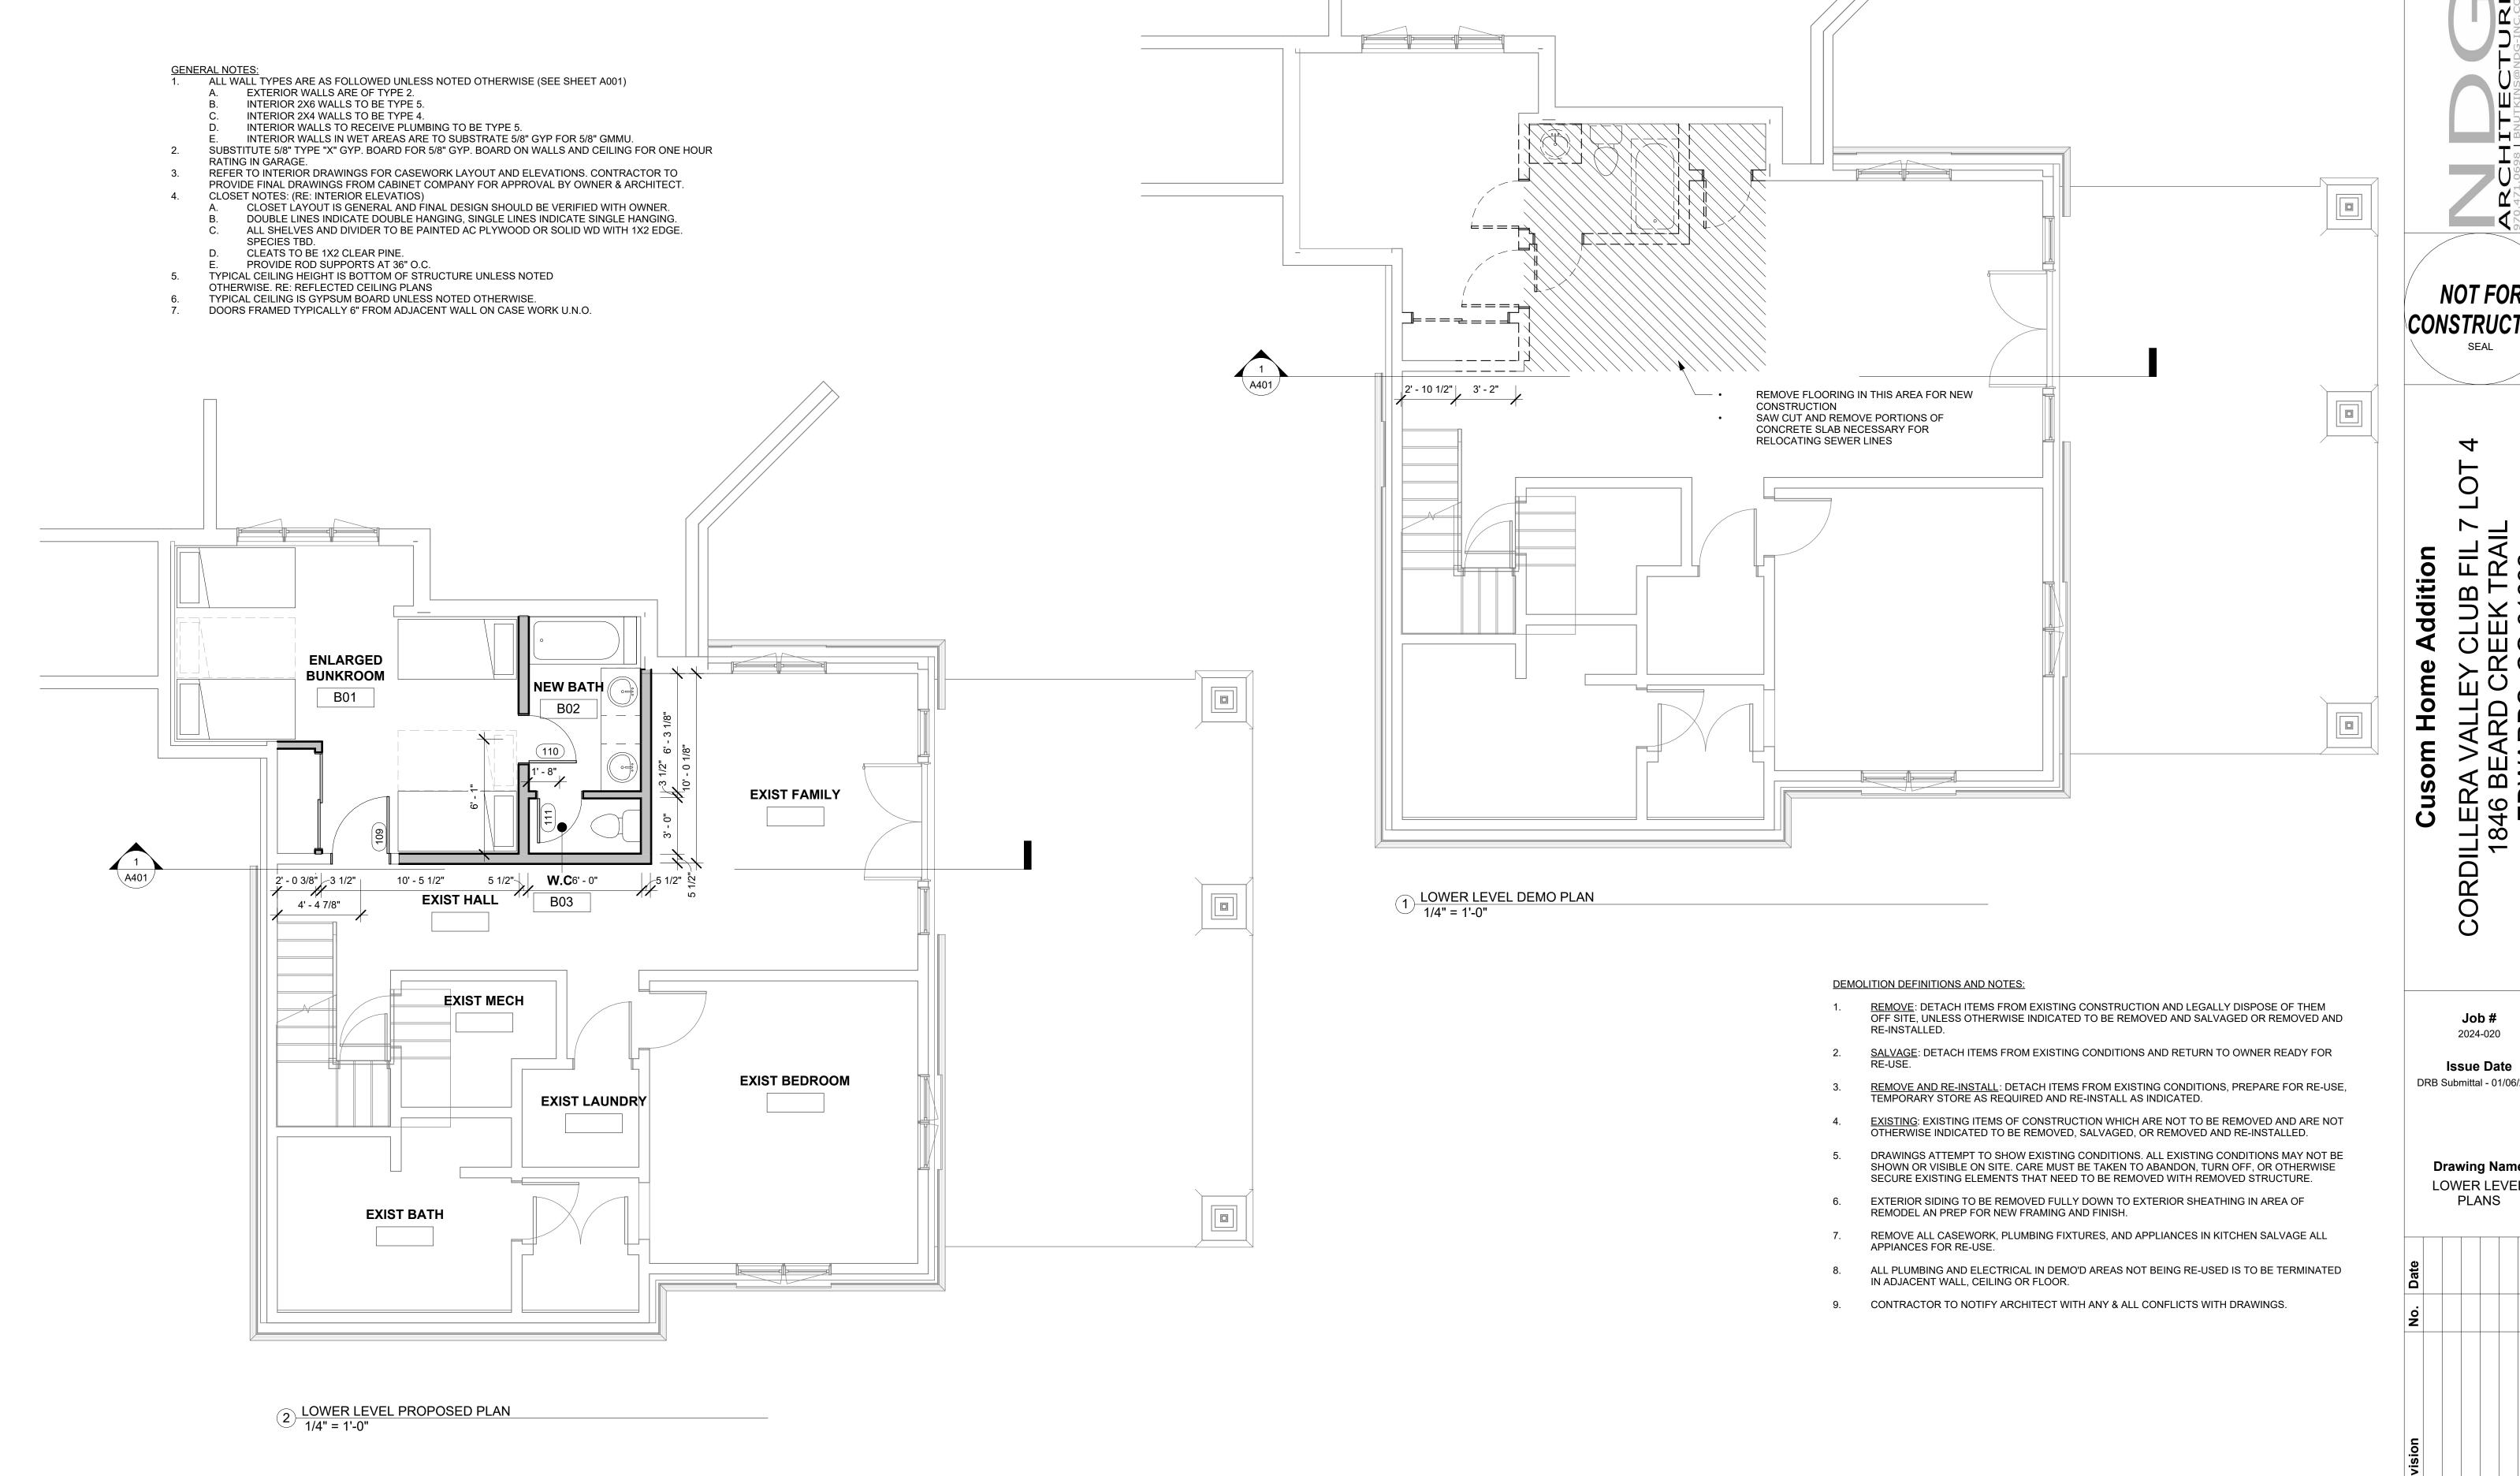

NOT FOR

CONSTRUCTION

Job# 2024-020

DRB Submittal - 01/06/2025

Drawing Name LOWER LEVEL


Door Schedule						
Mark	From RM	To RM	Width	Height	Comments	
NEW BEDROOM LEVEL						
102	VESTIBULE	GUEST BED 1	3' - 0"	7' - 0"		
103		GUEST BED 1	5' - 0"	7' - 0"	BY-PASS CLOSET	
104	GUEST BED 1	GUEST BATH 1	2' - 6"	7' - 0"		
105	VESTIBULE	GUEST BED 2	3' - 0"	7' - 0"		
106		GUEST BED 2	6' - 0"	8' - 0"	BY-PASS CLOSET	
107	GUEST BED 2	GUEST BATH 2	2' - 6"	7' - 0"		
MAIN LEVE	L					
101		VESTIBULE	3' - 0"	8' - 0"	BARN DOOR	


GENERAL NOTES:

- ALL WALL TYPES ARE AS FOLLOWED UNLESS NOTED OTHERWISE (SEE SHEET A001)

 A. EXTERIOR WALLS ARE OF TYPE 2.

 - INTERIOR 2X6 WALLS TO BE TYPE 5. INTERIOR 2X4 WALLS TO BE TYPE 4.
 - INTERIOR WALLS TO RECEIVE PLUMBING TO BE TYPE 5.
- INTERIOR WALLS IN WET AREAS ARE TO SUBSTRATE 5/8" GYP FOR 5/8" GMMU. SUBSTITUTE 5/8" TYPE "X" GYP. BOARD FOR 5/8" GYP. BOARD ON WALLS AND CEILING FOR ONE HOUR
- RATING IN GARAGE. REFER TO INTERIOR DRAWINGS FOR CASEWORK LAYOUT AND ELEVATIONS. CONTRACTOR TO
- PROVIDE FINAL DRAWINGS FROM CABINET COMPANY FOR APPROVAL BY OWNER & ARCHITECT.
- CLOSET NOTES: (RE: INTERIOR ELEVATIOS)
- CLOSET LAYOUT IS GENERAL AND FINAL DESIGN SHOULD BE VERIFIED WITH OWNER. DOUBLE LINES INDICATE DOUBLE HANGING, SINGLE LINES INDICATE SINGLE HANGING.
- ALL SHELVES AND DIVIDER TO BE PAINTED AC PLYWOOD OR SOLID WD WITH 1X2 EDGE.
- CLEATS TO BE 1X2 CLEAR PINE.
- PROVIDE ROD SUPPORTS AT 36" O.C.
- TYPICAL CEILING HEIGHT IS BOTTOM OF STRUCTURE UNLESS NOTED OTHERWISE. RE: REFLECTED CEILING PLANS
- TYPICAL CEILING IS GYPSUM BOARD UNLESS NOTED OTHERWISE.
- DOORS FRAMED TYPICALLY 6" FROM ADJACENT WALL ON CASE WORK U.N.O.

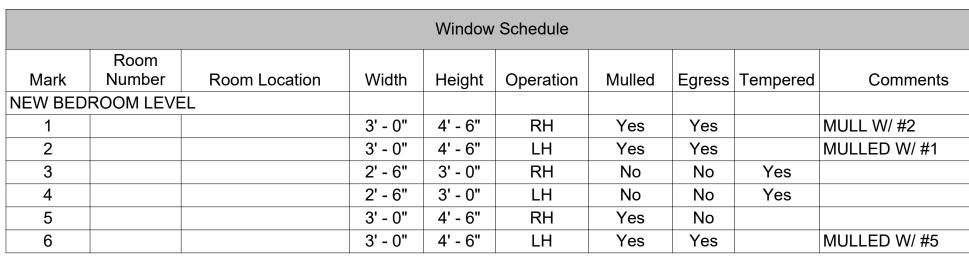

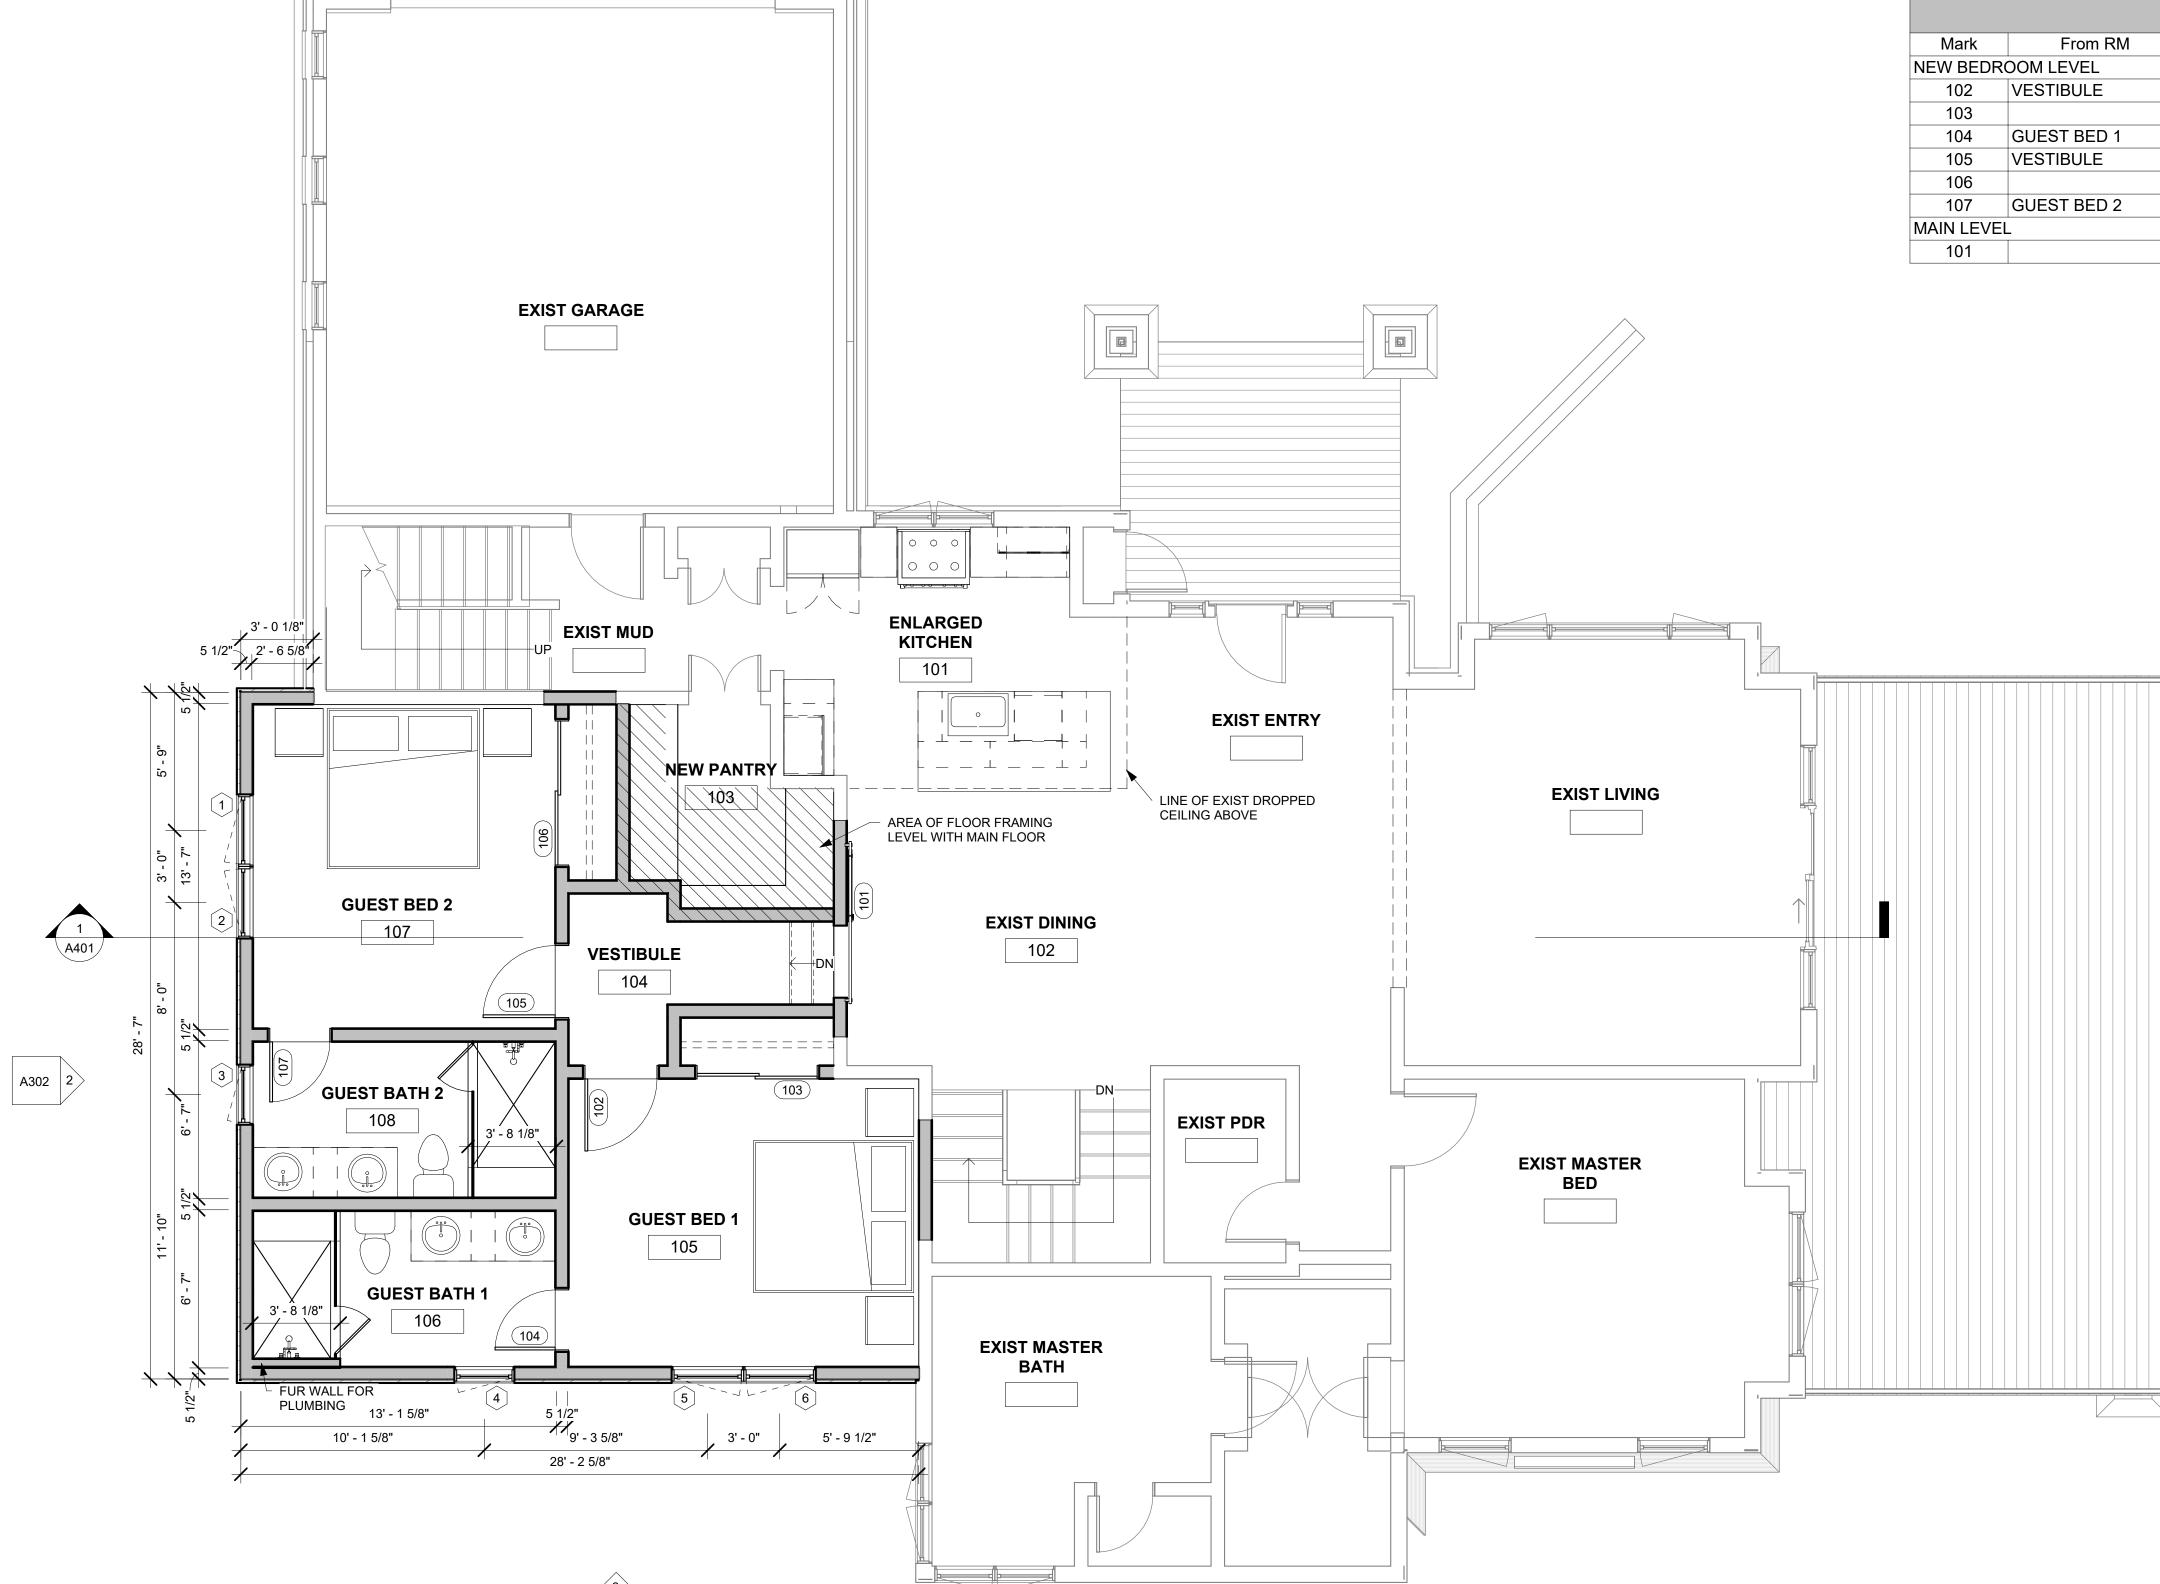

O CORDILLERA VA 1846 BEAF EDWAR


NOT FOR


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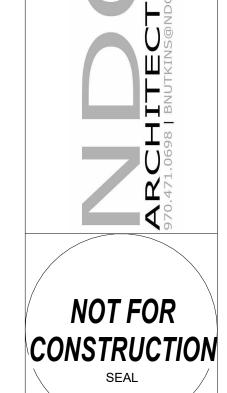
Job# 2024-020

Issue Date DRB Submittal - 01/06/2025

> **Drawing Name** MAIN LEVEL PLANS



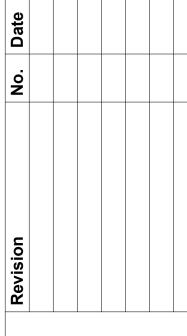

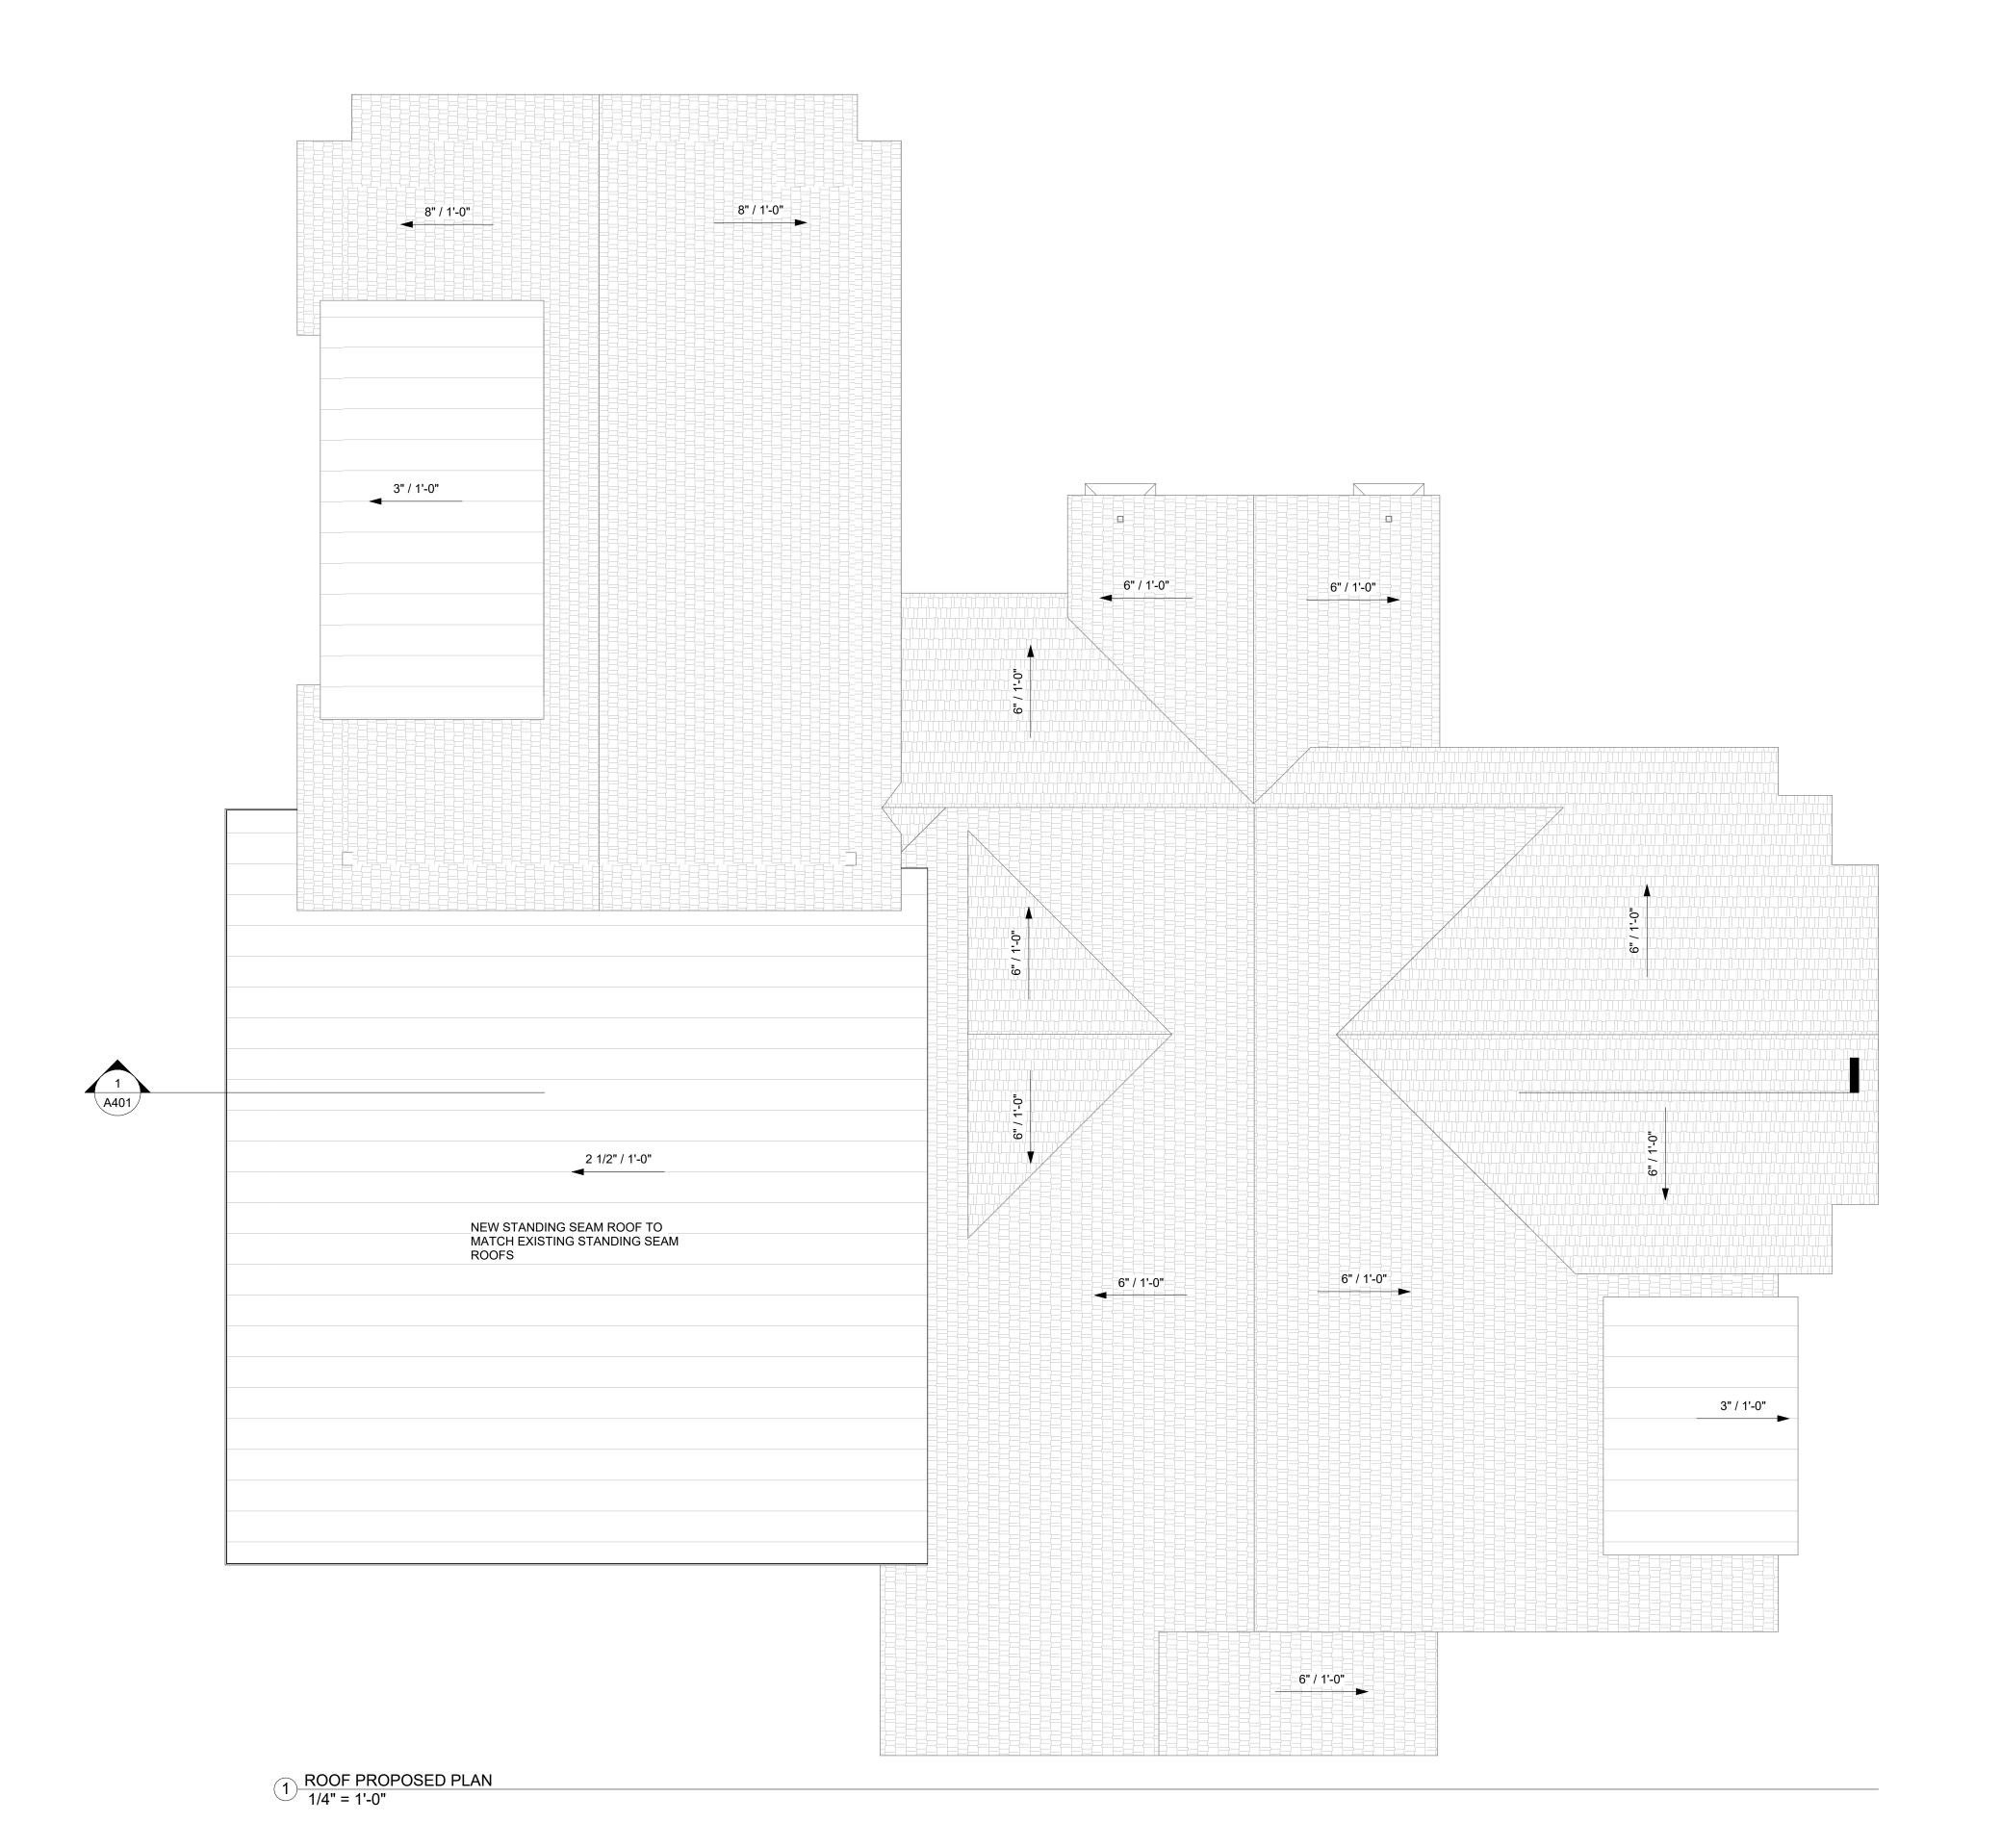

Job #
2024-020


Issue Date

Submittal - 01/06/202

CORDILLERA VALLEY CLUB FIL 7 L 1846 BEARD CREEK TRAIL EDWARDS, CO 81632

Issue Date
DRB Submittal - 01/06/2025

Drawing Name REMODEL ROOF PLAN

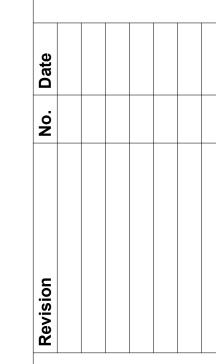

EXTERIOR FINISH
X-1 DRY STACK STONE VENEER TO MATCH EXIST

X-2 SLANTED HORIZONTAL WD SIDING TO MATCH EXIST

X-3 SHINGLE SIDING TO MATCH EXISTING

DOORS & WINDOWS - METAL CLAD WINDOWS, COLOR - TO MATCH EXIST

2X6 WD TO MATCH EXIST 2X6 WD TO MATCH EXIST 2X6 TO MATCH EXIST

TO MATCH EXIST 6X14 WD, TO MATCH EXIST

HSS PER STRUCT W/ STONE WRAPPED WD FRAMING


CORNER BOARDS 2X6 TO MATCH EXIST

NOT FOR CONSTRUCTION

Job# 2024-020

Issue Date DRB Submittal - 01/06/2025

Drawing Name SOUTH EXT. ELEVATIONS

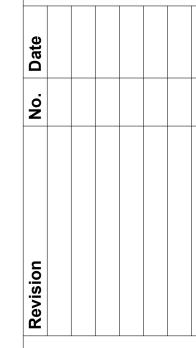

PROPOSED SOUTH ELEVATION
1/4" = 1'-0"

MAIN LEVEL 100' - 0"

LOWER LEVEL - 89' - 0"



ARCHITECTURE 970.471.0698 | BNUTKINS@NDG-INC.COM


NOT FOR CONSTRUCTION SEAL


CORDILLERA VALLEY CLUB FIL 7 LOT 4
1846 BEARD CREEK TRAIL
EDWARDS, CO 81632

Job # 2024-020

Issue DateDRB Submittal - 01/06/2025

Drawing NameEAST EXT.
ELEVATIONS

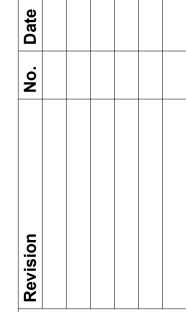

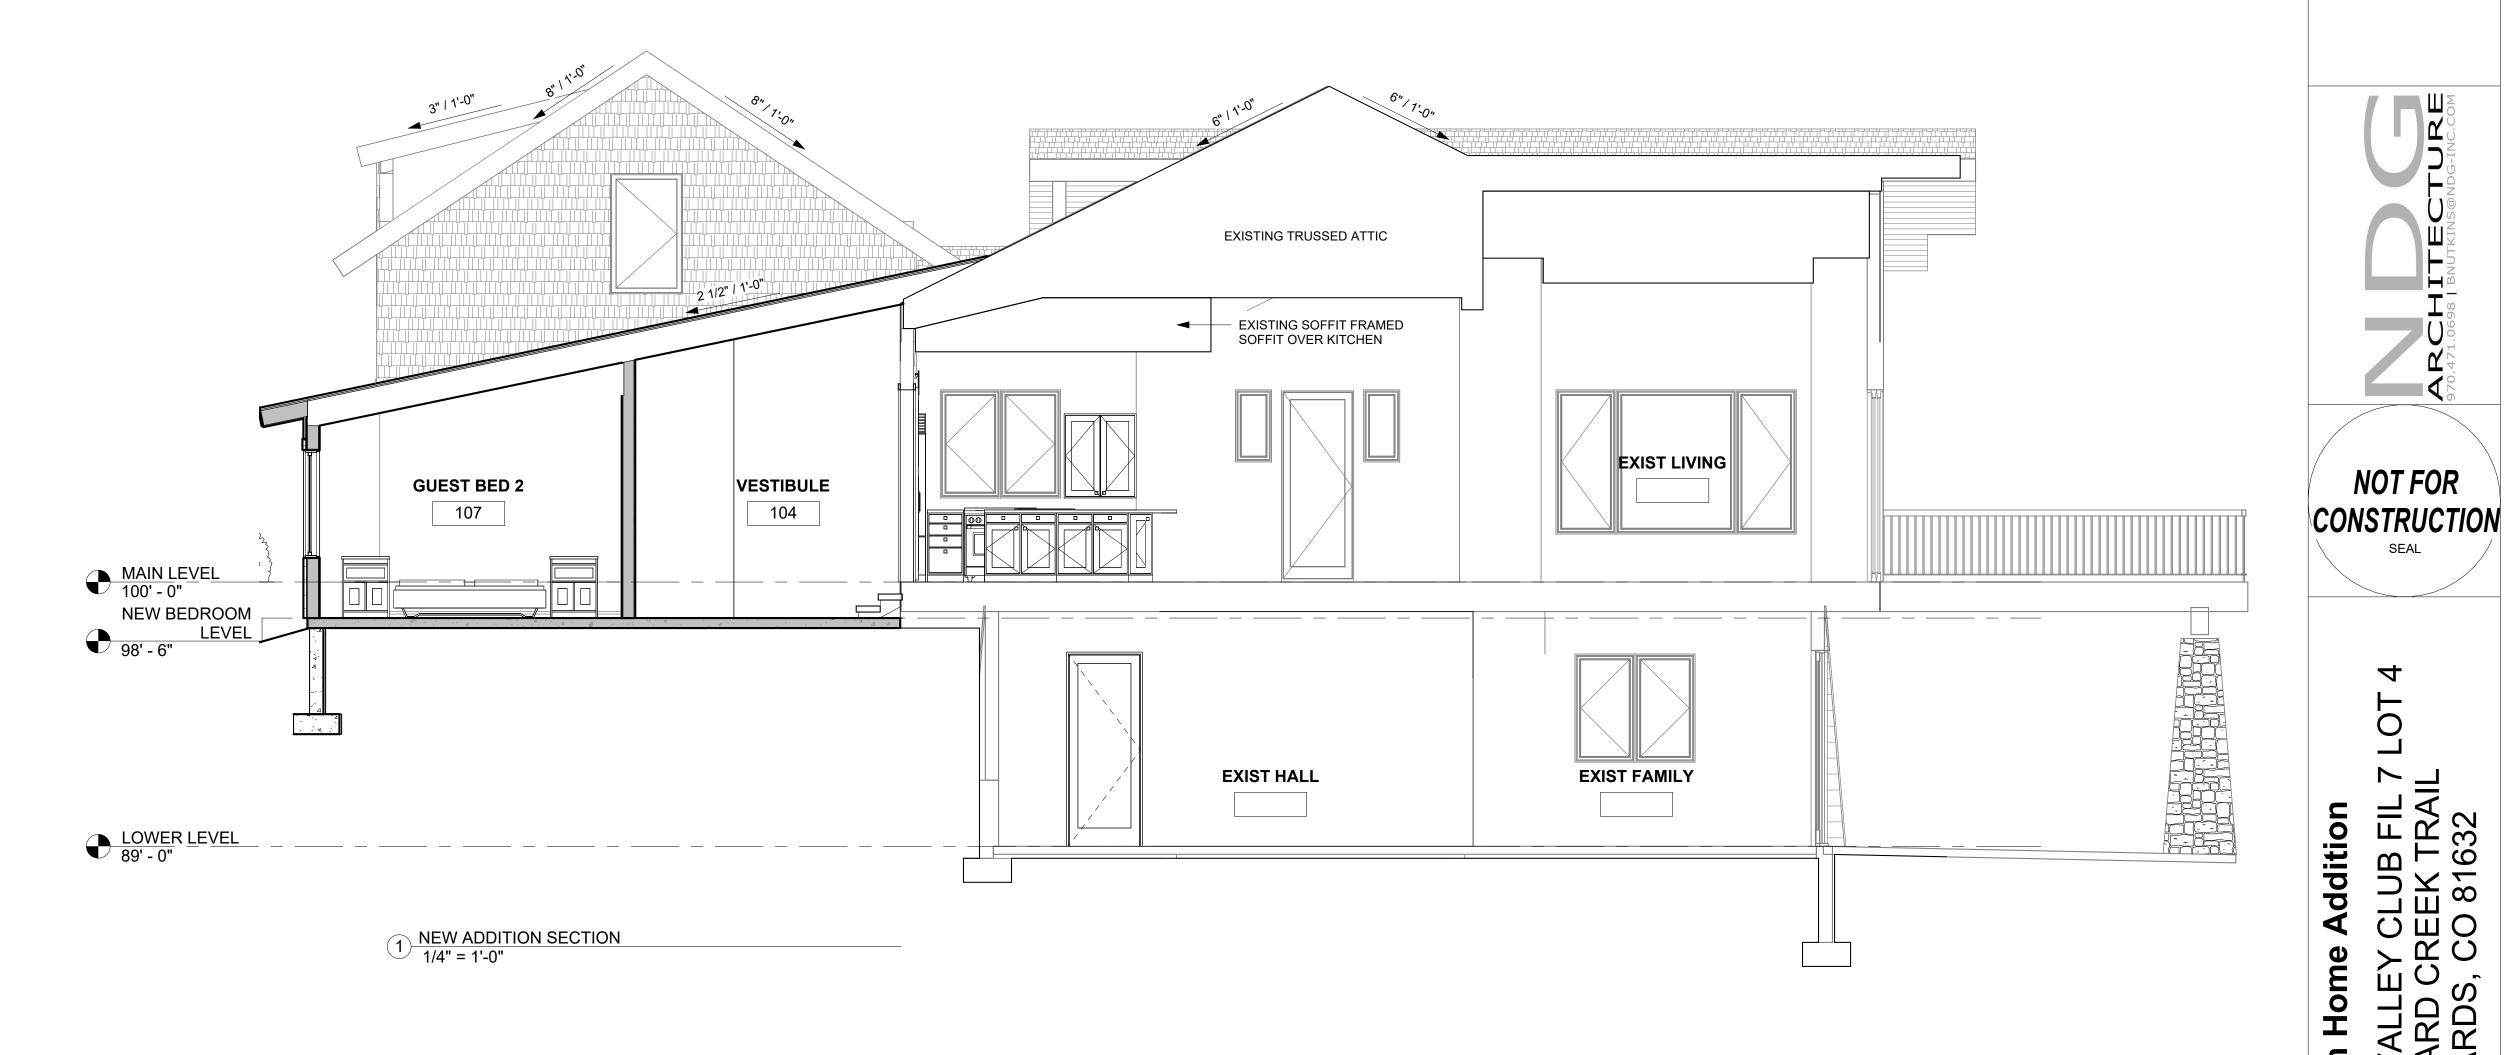


CORDILLERA VALLEY CLUB FIL 7 1846 BEARD CREEK TRAIL EDWARDS, CO 81632

NOT FOR

Job # 2024-020 Issue Date DRB Submittal - 01/06/2025

> **Drawing Name** BUILDING SECTIONS

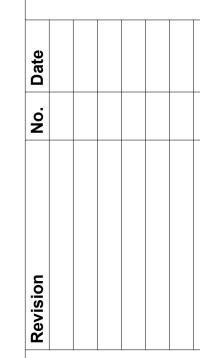

WD SIDING TO MATCH EXIST EXTERIOR FINISH (RE: ELEVS) ON WEATHER RESISTANT BARRIER OVER 1/2" SHEATHING ON 2X SLOPED WOOD

SLEEPERS ON 2X6 WALL FRAMING WITH 3 1/2"+ SPRAY FOAM INSULATION

RETARDÉR AND 5/8" GYPSUM WALL

(R-21 MIN). MEMBRANE VAPOR

BOARD ON WALL INTERIOR

7 BASE OF WALL 1" = 1'-0"

2X10 PRESSURE TREATED SILL

- FOUNDATION PER STRUCT

— 1 1/2" RIGID INSULATION

FLOORING PER OWNER

6" COMPACTED GRAVEL

FOUNDATION PER STRUCT

STEEL ANGLE BRACKET PER STRUCT

- 2X FURRING 1/2" OFF FACE OF CONCRETE

1 1/2" RIGID INSULATION FOR 4'-0" FROM EDGE OF SLAB TO THE INTERIOR

<u>SILL</u>

8 WINDOW DETAILS 1 1/2" = 1'-0"

MEMBRANE VAPOR RETARDER AND 5/8" GYPSUM WALL BOARD ON WALL INTERIOR

- SEAL/FOAM THE PERIMETER OF ALL PENETRATIONS WD SIDING TO MATCH EXIST EXTERIOR

NOT FOR CONSTRUCTION

> SLUB FIL 7 EEK TRAIL O 81632 R O LER/ 846 E ED/ ORDIL 1

Job# 2024-020

Issue Date DRB Submittal - 01/06/2025

Drawing Name CONSTRUCTION **DETAILS**

